



**THE VILLAGE AT MILL POND**  
11 KILLINGWORTH TURNPIKE  
CLINTON, CONNECTICUT 06413

DESIGN GENERAL REVISION


REVISIONS  
No. 1  
Date 1/22/16

Designed E.C.P.  
Drawn M.A.A.  
Checked M.M.C.  
Approved  
Scale 1"=40'  
Project No. 14C4892  
Date 1/4/16

CAD File: EC14C489201

Title  
EROSION AND  
SEDIMENTATION  
CONTROL PLAN  
(PHASE 2)

Sheet No.

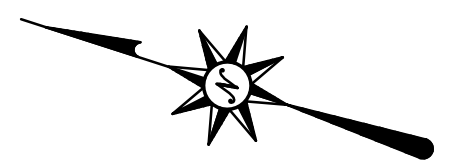


**EROSION CONTROL LEGEND**

CONTROL MEASURE	ILLUSTRATION
HAY BALES AT CATCH BASINS	[Symbol: Square with diagonal lines]
HAY BALE EROSION CONTROL	[Symbol: Dashed line]
SILT SACKS AT CATCH BASINS	[Symbol: Circle with vertical lines]
SEDIMENT CHECK DAM	[Symbol: U-shaped line]
DIVERSION SWALE	[Symbol: Line with arrows pointing away]
SILT FENCE	[Symbol: Line with 'SF' labels]
LIMIT OF DISTURBANCE LINE	[Symbol: Line with 'LOD' label]
CONSTRUCTION ENTRANCE	[Symbol: Stippled area]
STOCKPILE AREA WITH DOUBLE ROW SILT FENCE OR SINGLE ROW WOOD CHIP BERM WITH HAY BALES	[Symbol: Circle with stippled area]


**SOIL TYPES**

- 13-WALPOLE SANDY LOAM, 0 TO 3 PERCENT SLOPES
- 18-CATDEN FREETOWN SOILS, 0 TO 2 PERCENT SLOPES
- 23A-SUDBURY SANDY LOAM, 0 TO 5 PERCENT SLOPES
- 29A-ADAWAM FINE SANDY LOAM, 0 TO 3 PERCENT SLOPES
- 29B-ADAWAM FINE SANDY LOAM, 3 TO 8 PERCENT SLOPES
- 34A-MERRIMAC FINE SANDY LOAM, 0 TO 3 PERCENT SLOPES
- 73C-CHARLTON-CHATFIELD COMPLEX, 3 TO 15 PERCENT SLOPES, VERY ROCKY
- 238C-HINCKLEY-URBAN LAND COMPLEX, 3 TO 15 PERCENT SLOPES
- 305-UDORTHERTS-PITS COMPLEX, GRAVELLY
- 307-URBAN LAND
- 308-UDORTHERTS, SMOOTHED
- W-WATER

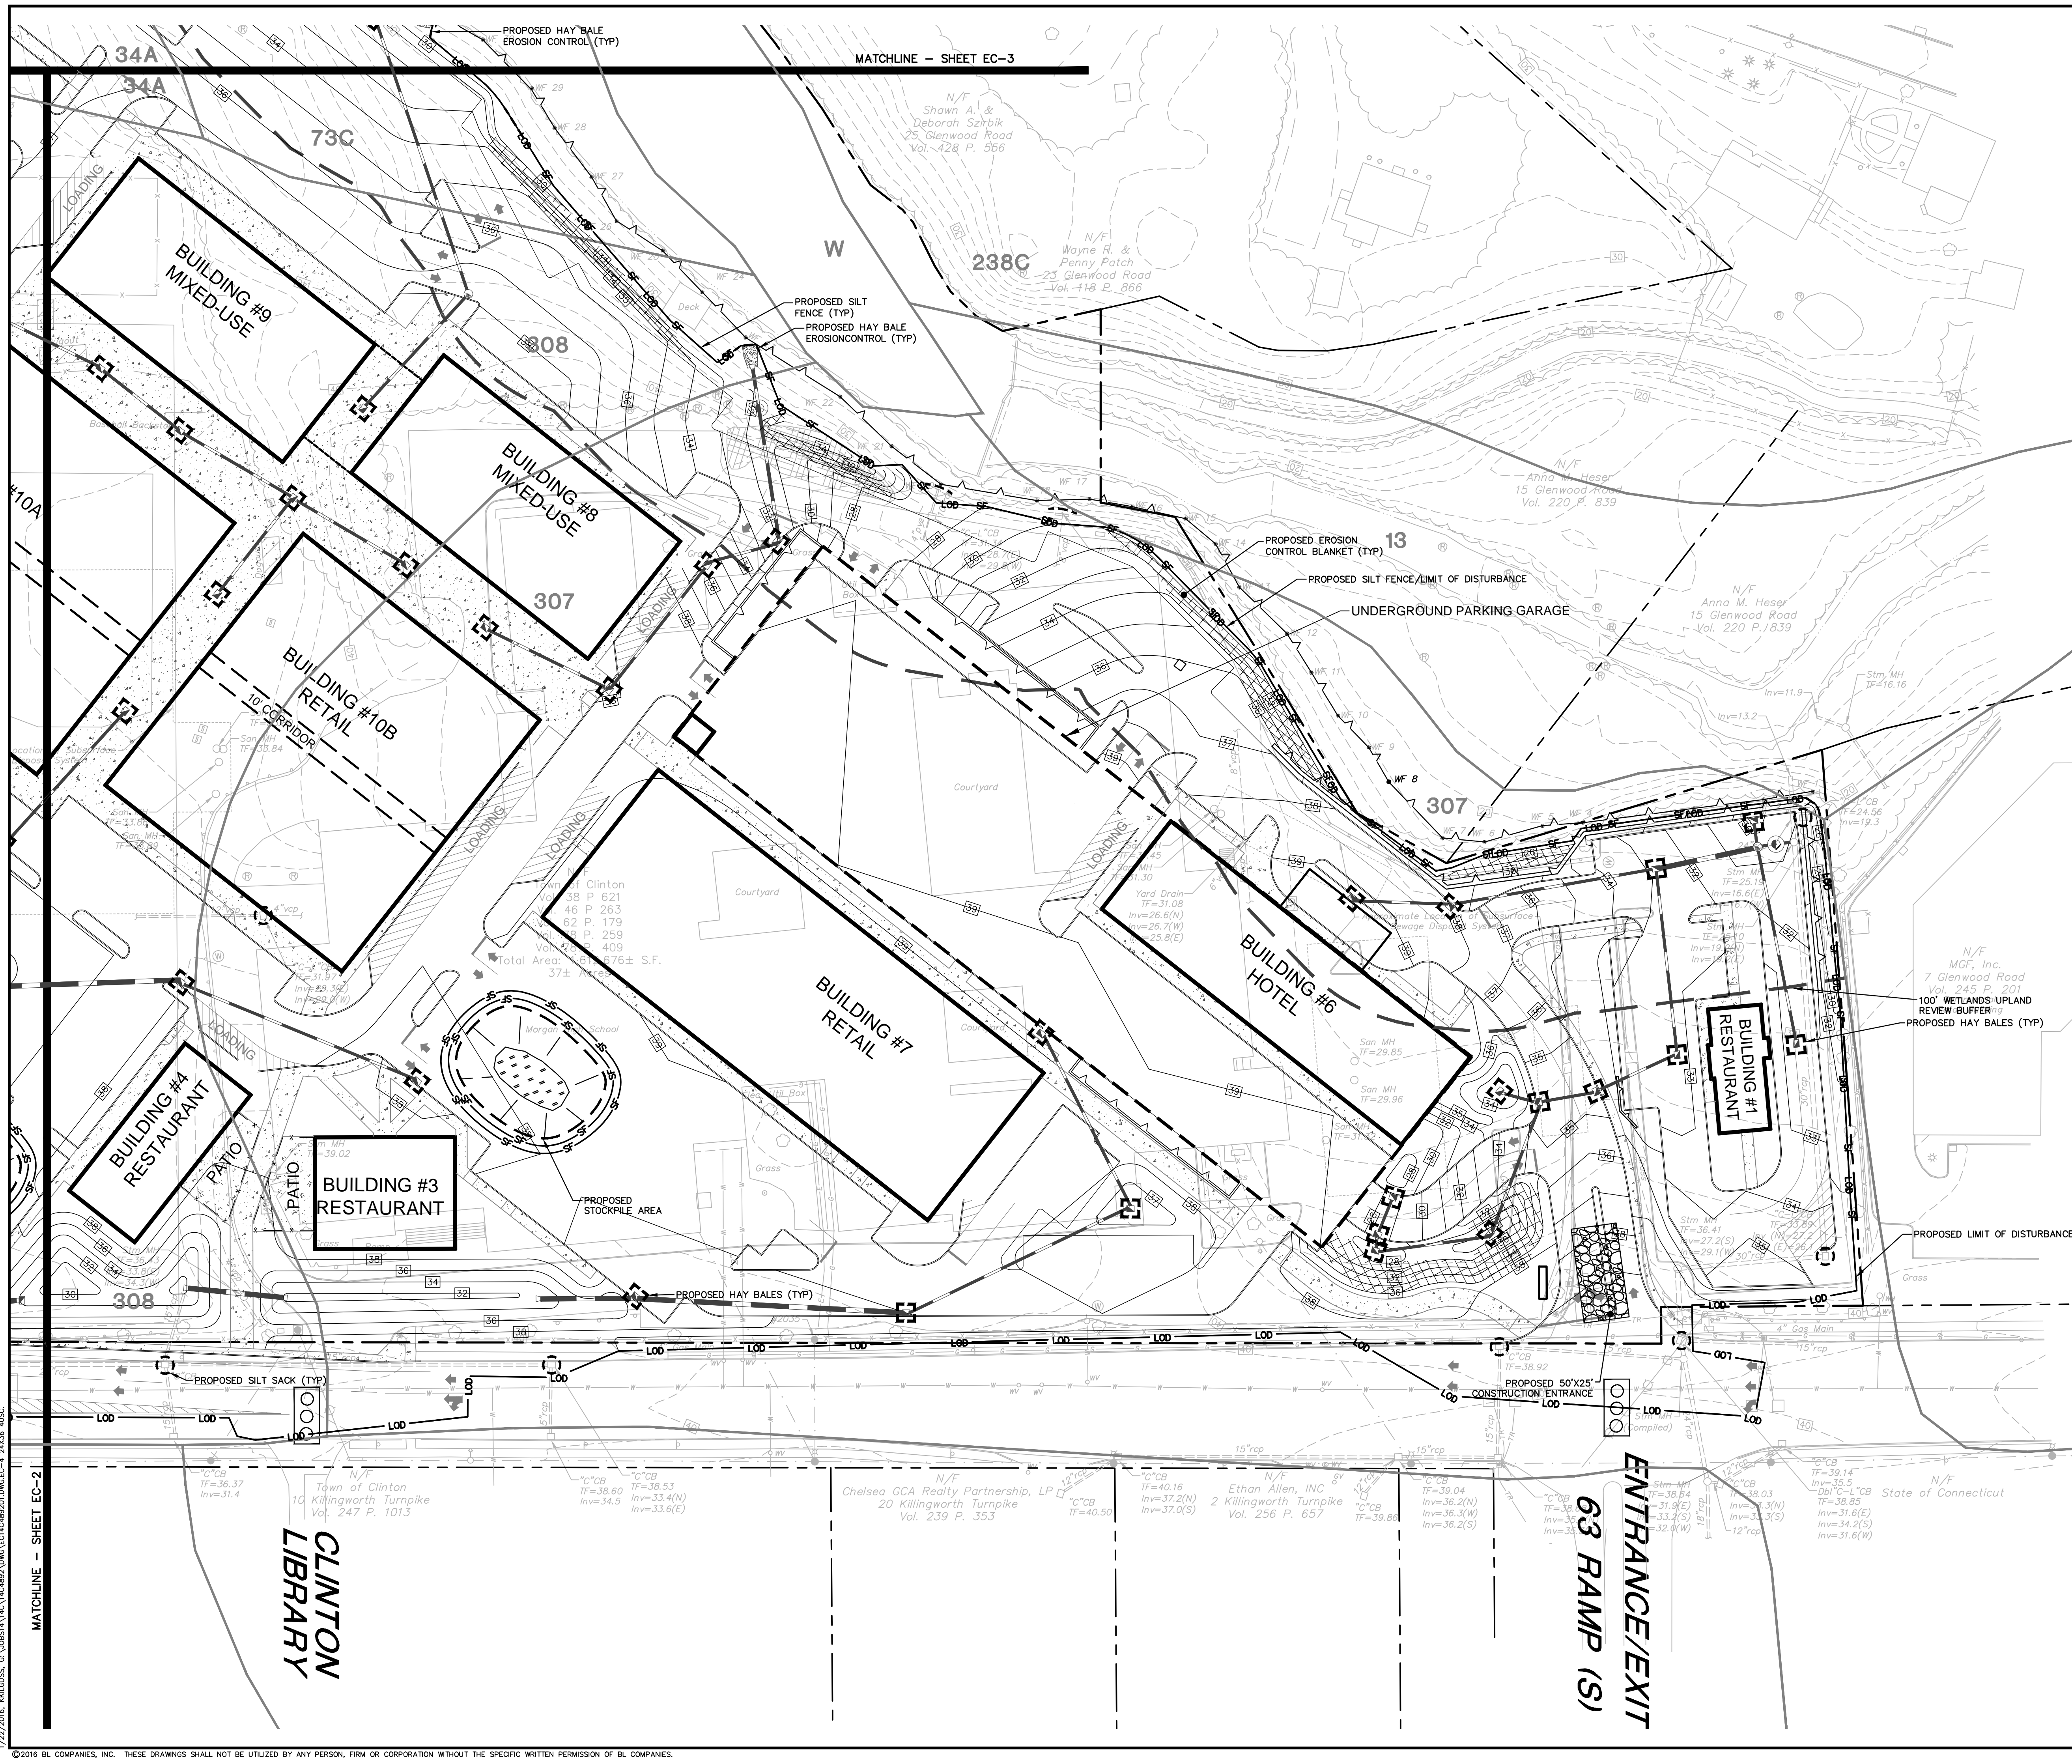

**FOR PERMITTING PURPOSES ONLY  
NOT RELEASED FOR CONSTRUCTION**

**REFER TO SHEET EC-7 FOR  
EROSION CONTROL NOTES**

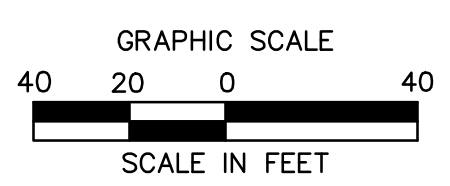

1/22/2016, KKL/ISS, G. VORREI\14C489201\DWG\EC-4 24X36 40SC

MATCHLINE - SHEET EC-2

MATCHLINE - SHEET EC-3